

BCIN 20485 I 905-269-7563

28-AUG-25

DRAWN & CHECKED BY: MALLORY THERIAULT


I HAVE REVIEWED \$ TAKE RESPONSIBILITY FOR THIS DESIGN

ADAM BATEELAN GARAGE GUYS CONTRACTING

DATE BY

| " = | O' - O'

1 OF 3

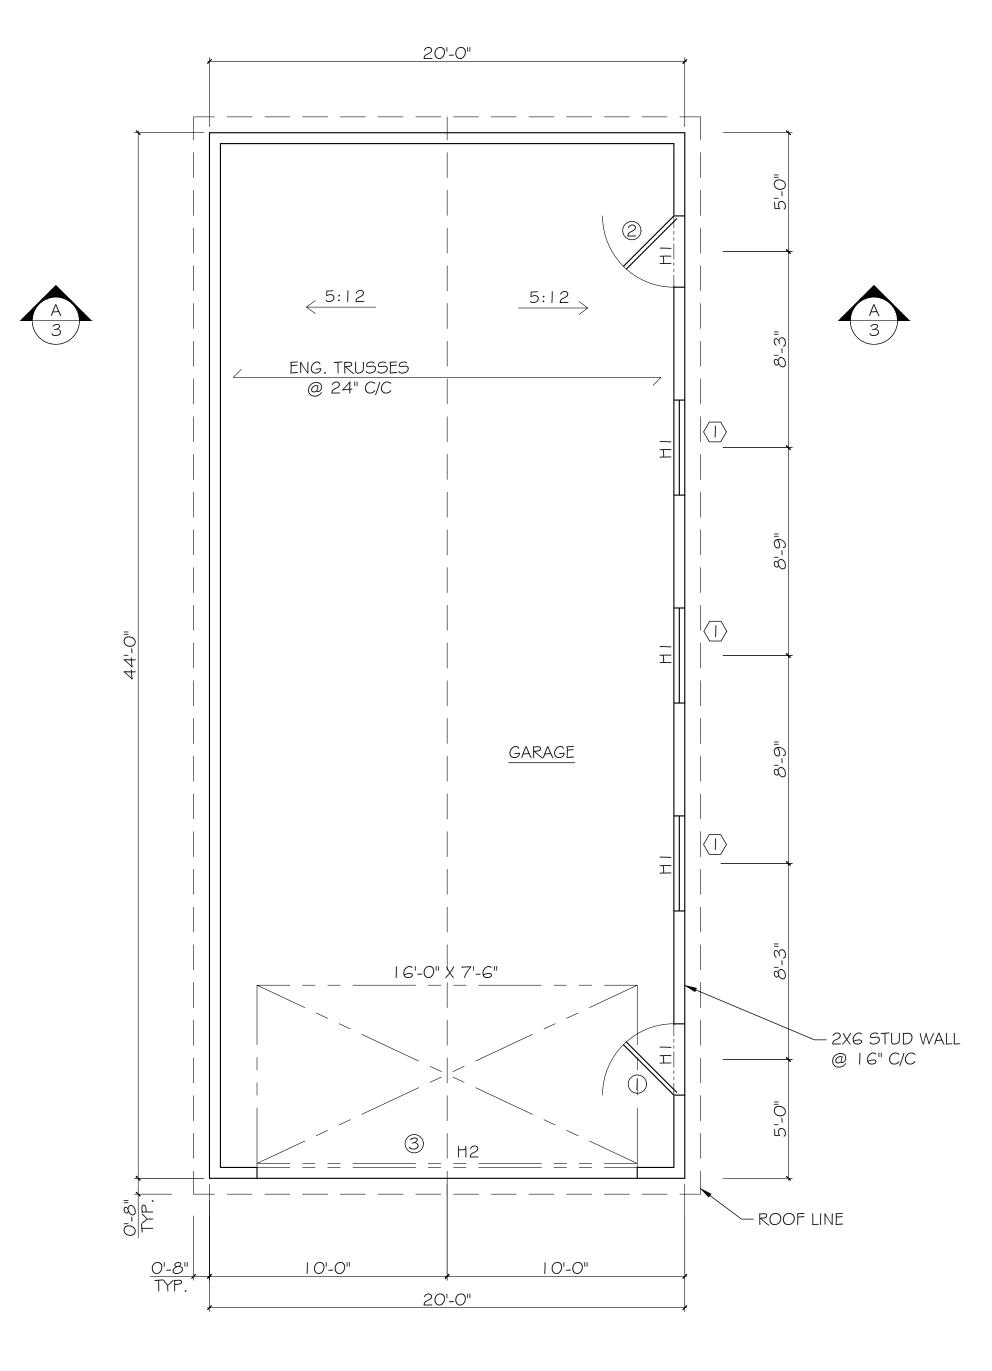



AREA:
GARAGE: 880 SQ.FT.

CONSTRUCTION NOTES:

- I. REFERENCE STANDARD ONTARIO BUILDING CODE 2024 (OBC). REFER TO THE OBC FOR DETAILS NOT INCLUDED HERE.
- 2. VERIFY ALL DIMENSIONS PRIOR TO COMMENCEMENT OF CONSTRUCTION.

 3. WHERE SITE CONDITIONS REQUIRE DEVIATION FROM THESE PLANS THE BUILDER SHALL N
- 3. WHERE SITE CONDITIONS REQUIRE DEVIATION FROM THESE PLANS THE BUILDER SHALL NOTIFY THE DESIGNER SO THAT SUITABLE CHANGES TO THE DESIGN CAN BE MADE.
- 4. UNLESS OTHERWISE SPECIFIED EXTERIOR WALLS ARE DIMENSIONED TO THE EXTERIOR OF THE STUDS.
 5. STRUCTURAL LUMBER TO BE SPRUCE-PINE-FIR NO.2 OR BETTER.
- 6. USE GALVANIZED HARDWARE WHEN IN CONTACT WITH PRESSURE TREATED LUMBER.
- 7. FOLLOW MANUFACTURERS SPECIFICATIONS FOR FASTENERS IN METAL CONNECTORS.
- 8. SEAL ALL PENETRATIONS THROUGH THE AIR BARRIER WITH CAULKING AND TAPE.
- 9. HANG WINDOWS FROM 80" FROM TOP OF SLAB

ROOF NOTES:

- I. INSTALL AND BRACE NEW ROOF TRUSSES PER TRUSS ENGINEER'S DRAWINGS.
- 2. PROVIDE DROP GABLE TRUSS.
- 3. REFER TO TRUSS ENGINEER'S DRAWINGS FOR TRUSS HANGER SPECIFICATIONS.
- 4. GROUND SNOW LOAD 1.6kPa (TRENTON)
- RAIN LOAD 0.4kPa SPECIFIED SNOW LOAD 1.3kPa

DOOR SCHEDULE

SYM. SIZE DESCRIPTION QTY.


(1) 36X80 LH ENTRY DOOR I

(2) 36X80 RH ENTRY DOOR I

(3) 192X90 ROLL-UP DOOR I

	WIN	IDOW SCHEDULE	
SYM.	SIZE	DESCRIPTION	QTY
	48X30	SLIDER	3

HE	HEADER SCHEDULE		
SYM.	SIZE		
ΗΙ	2-2X4		
H2	2-2XIO		

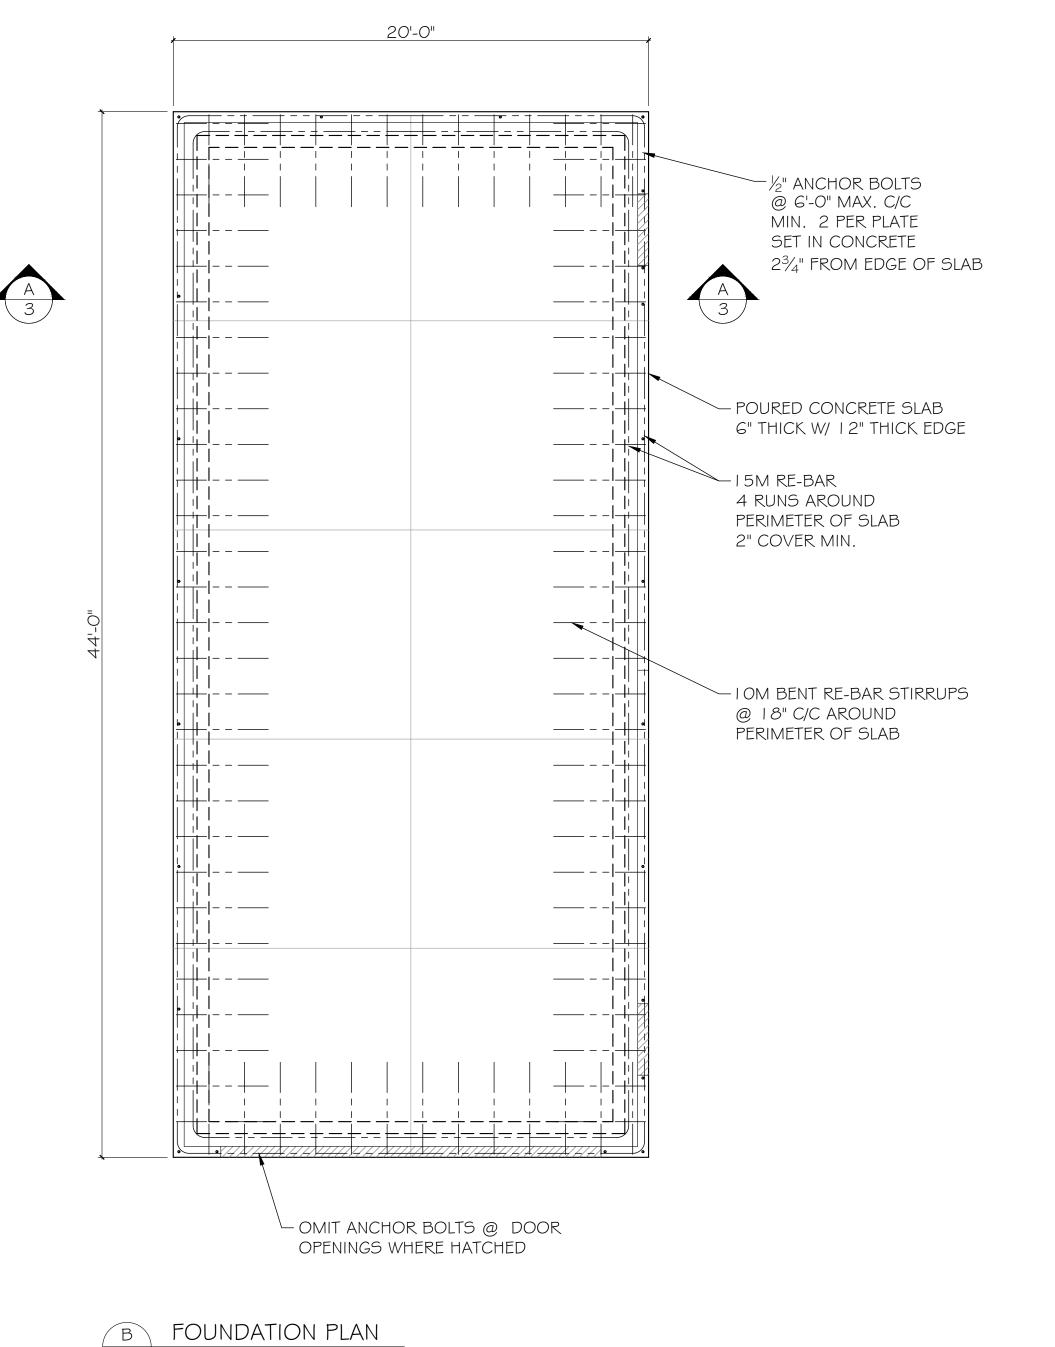

** FOUNDATION TO BE DESIGNED BY STRUCTURAL ENGINEER **

SLAB ON GRADE FOUNDATION NOTES:

- 1. CONCRETE MATERIAL TO BE 32 MPA MIN. AGED COMPRESSIVE STRENGTH, 5%-8% AIR ENTRAINED.
- SPIN TROWEL FINISH SURFACE.

SCALE 1/4" = 1'-0"

- 3. FASTEN WOOD FRAMING TO CONCRETE WITH 1/2" ANCHOR BOLTS EMBEDDED IN CONCRETE SPACED 6'-0" MAX. C/C. 2 PER SILL PLATE SECTION MINIMUM.
- 4. STRIP ALL ORGANIC TOPSOIL AND ANY UNSATISFACTORY SUBSOIL OFF THE ENTIRE BUILDING FOOTPRINT PLUS A MINIMUM OF 3'-O" ALL AROUND THE OUTSIDE OF THE FOOTPRINT. REMOVE ALL STUMPS AND ROOTS FROM THE FOOTPRINT, BACKFILL HOLES WITH WELL COMPACTED GRANULAR FILL.
- 5. UP-FILL SITE AS REQUIRED FOR THE BUILDING. USE GOOD CLEAN GRANULAR FILL (CRUSHER RUN/BREAKER RUN FOR THICKER FILL DEPTHS, CLEAR $\frac{3}{4}$ " STONE OR GRANULAR 'A' FOR FINAL TOPPING OF FILL). UP-FILL IN LAYERS WELL MECHANICALLY COMPACTED.
- 6. "PROOF ROLL" TOP OF FILL WITH VIBRATING PLATE TAMPER OR VIBRATING ROLLER COMPACTOR.
- 7. ESTABLISH FINAL LEVEL OF THE BUILDING AND FINAL SITE GRADES SO THAT THE SITE IS SLOPED AWAY FROM THE BUILDING ON ALL SIDES. ESTABLISH FINAL EXTERIOR GRADE TO BE 6" BELOW TOP OF SLAB. RAMP UP GRADE AT DOORWAYS TO 1" BELOW TOP OF SLAB.
- 8. DO NOT SET ONE CORNER OF THE SLAB ON BEDROCK AND THE REST ON FILL. IF BEDROCK IS ENCOUNTERED ENSURE A MINIMUM OF 6" OF FILL OVER THE ROCK AND COMPACT THE REST OF THE UNDER-FLOOR FILL THOROUGHLY.



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Garage.dwg

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I BRIDGE ST E, BELLEVILLE


CONTENTS


RAGE PLAN & FOUNDATION PLAN

SCALE 1/4" = 1'-0"

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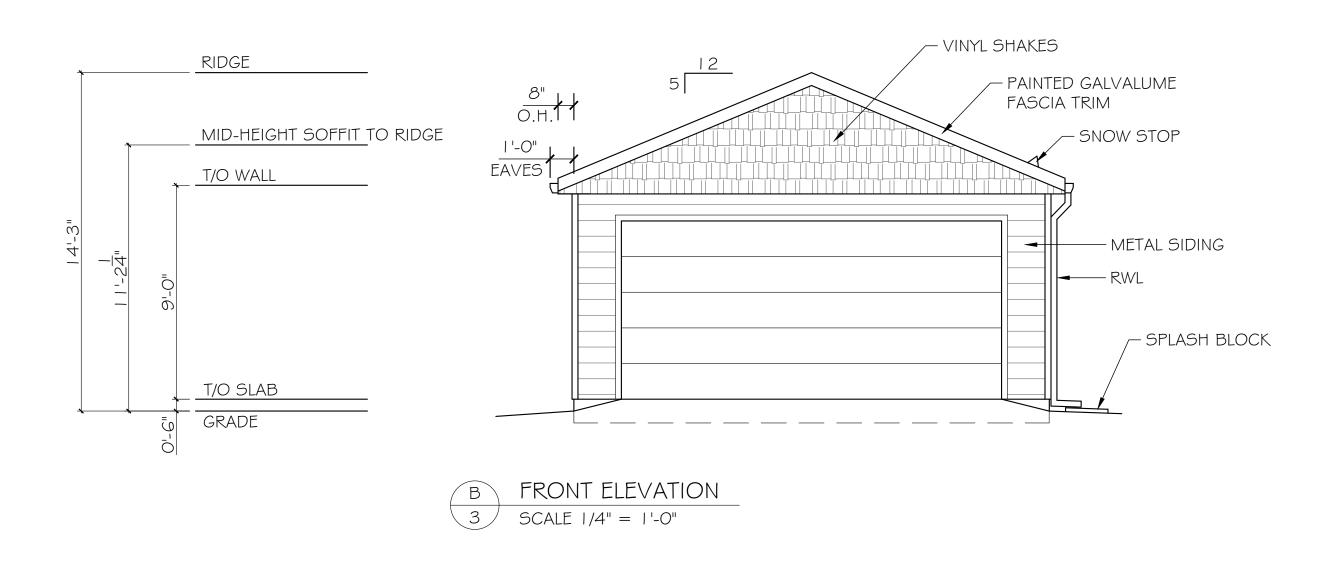
SHEET NO. 2 OF 3




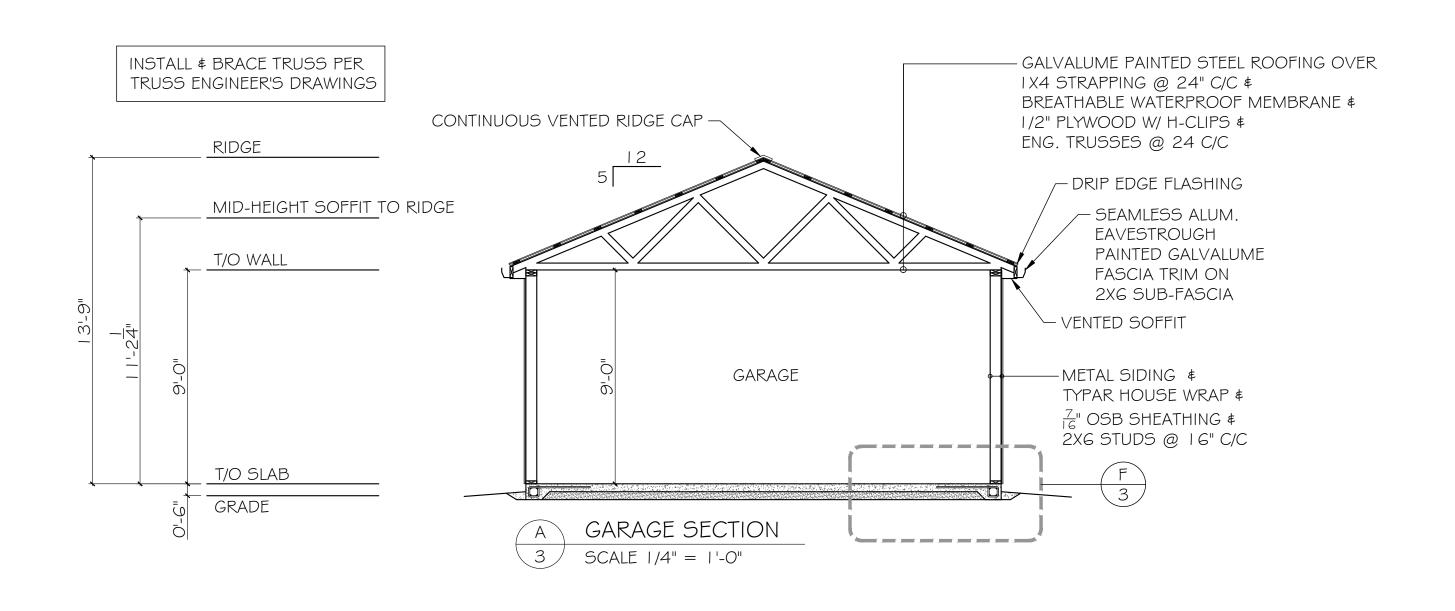

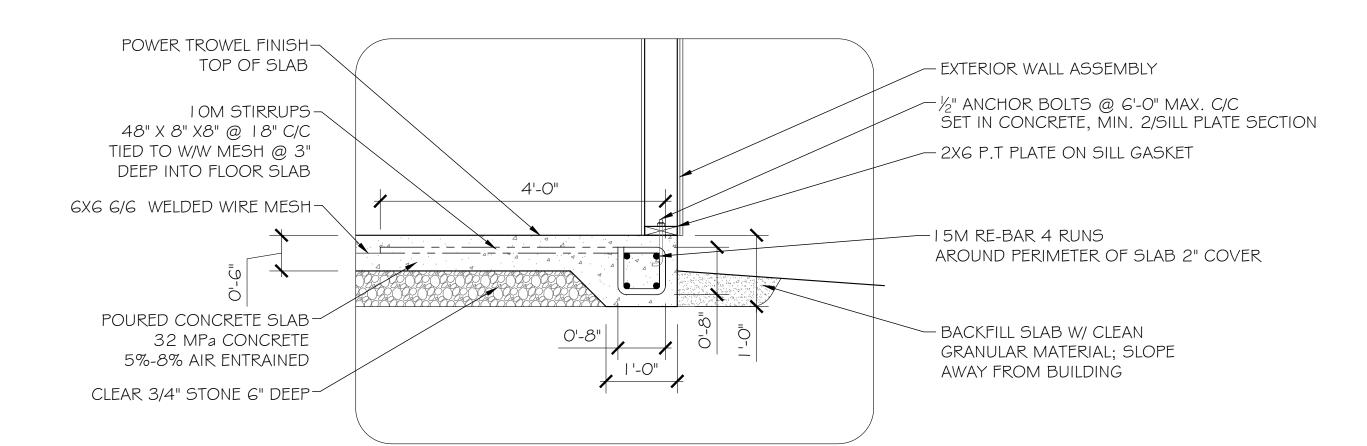F EDGE OF GARAGE SLAB DETAIL


3 SCALE 3/4" = 1'-0"



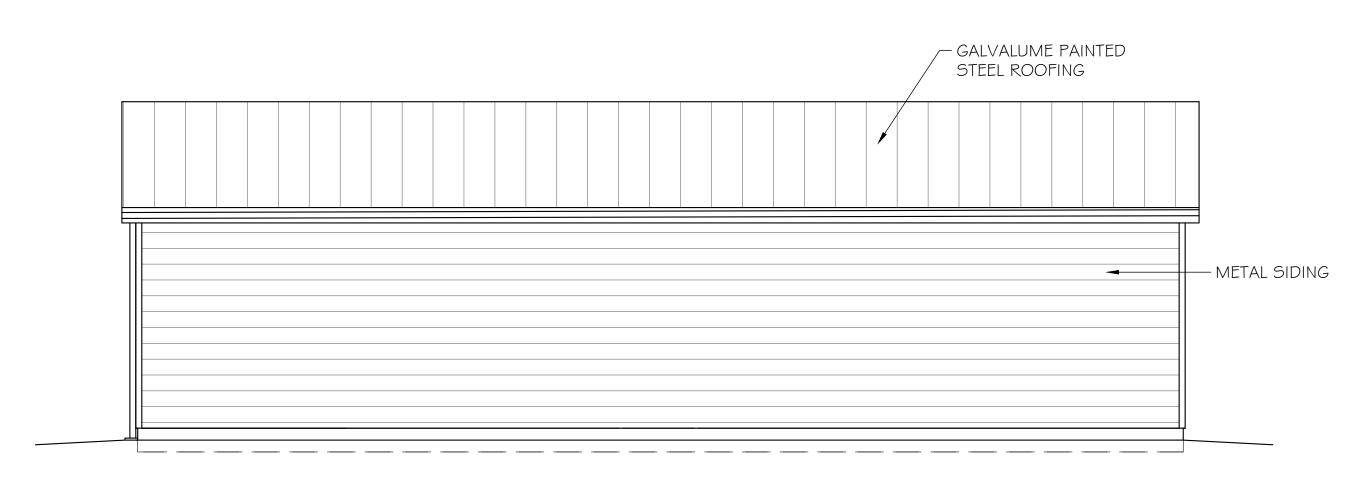


C LEFT SIDE ELEVATION

3 SCALE 1/4" = 1'-0"

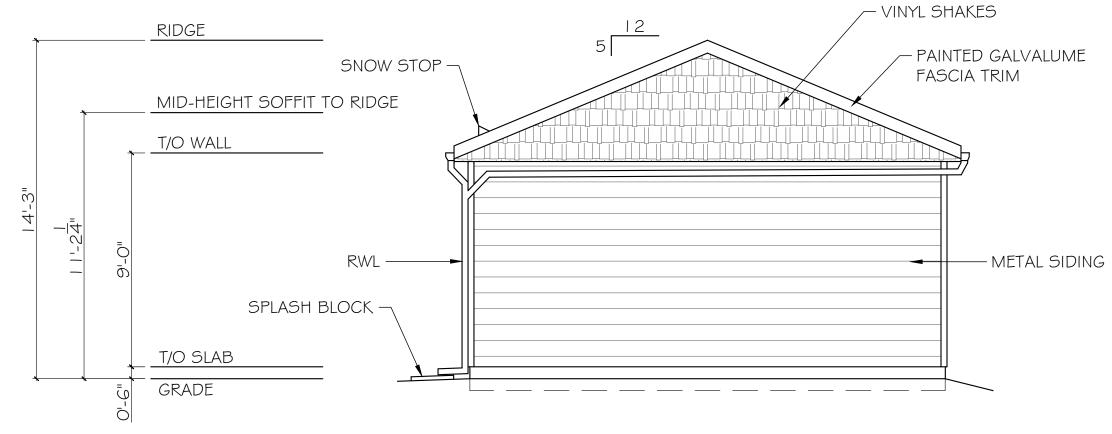


D REAR ELEVATION

3 SCALE 1/4" = 1'-0"

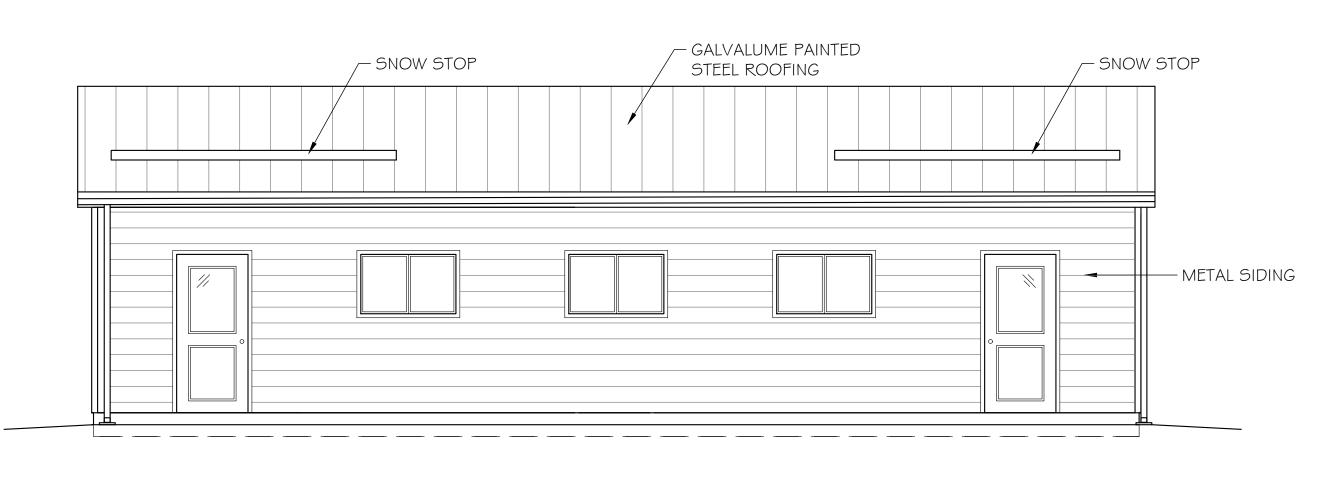

E RIGHT SIDE ELEVATION

3 SCALE 1/4" = 1'-0"

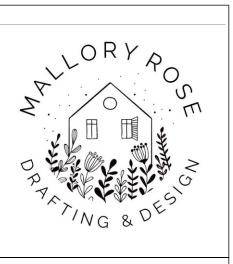

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SHEET CONTENTS

SECTION, ELEVATIONS & EDGE OF SLAB DETAIL

scale AS NOTED

SHEET NO.

3 OF 3